

# City of Cranston Zoning Board of Review December 11, 2024

Chairman of the Board Christopher E. Buonanno

## **Members**

Joy Montanaro (Vice-Chair) Ivy Swinski Dean Perdikakis Carlos Zambrano

Anthony Mastantuono (1st Alternate)
Vacant (2nd Alternate)
Frank Corrao III (3rd Alternate)
Vacant (4th Alternate)


## ► Ward 6

▶THOMAS J. DONELLY and MELISSA A. DONELLY (OWN/APP) have applied to the Board to allow an accessory garage structure to be built in the required front yard setback at 24 Normandy Drive, A.P. 15, lot 1023; area 6,957sf; zoned A-8. Applicant seeks relief per Section 17.92.010-Variances; Section 17.60.010(B)- Location of Residential Accessory Buildings.

► Application filed 10/8/2024. No Attorney.



# 24 Normandy Dr 400' Radius Plat 15 Lot 1023

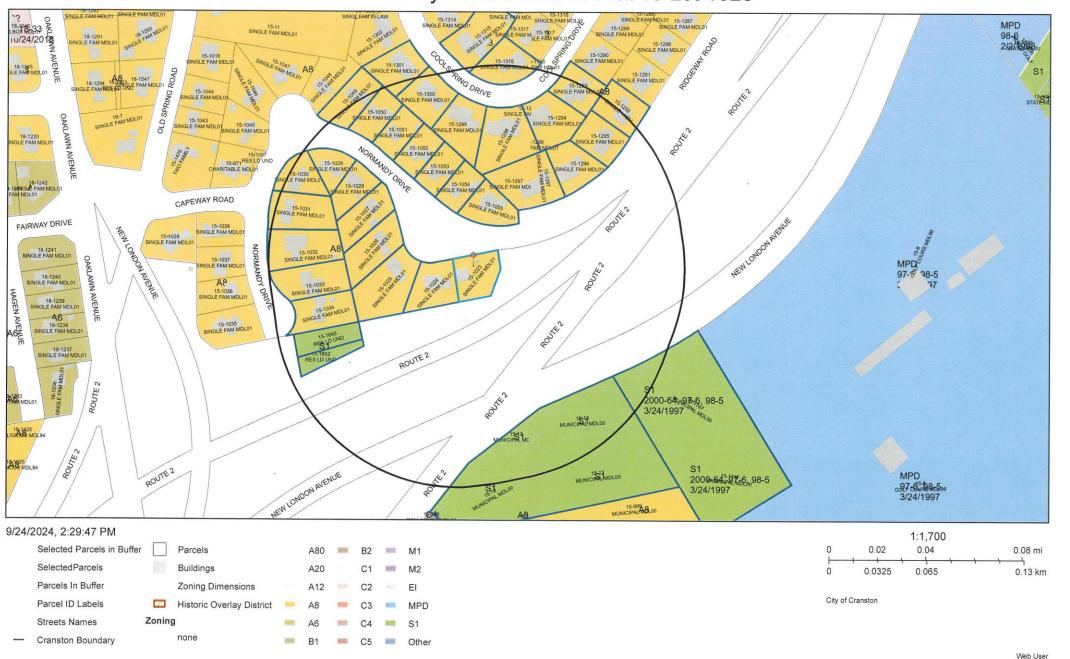


City of Cranston |


Thomas J. WONNELLY 401-623-1116 ZUNORWANDY Drive CRIANSTON, RI 62920 PERMIT GRANTED HOT 111 DE COMPLIANCE 5 hed CRANSTON BUILDING DEP wood Fence 47 FT. GARAGE WIRE ZOFT 24 NORM ANDY Drive NEW Amended Draft 06/27/2023


## ACCESSORY BUILDING 20' X 20' = 400 SQ FT


DRAWING INDEX

S1 • PROJECT NOTES, ELEVATIONS
S2 • PLANS, SHEAR WALL SCHEDULE
S3 • SECTIONS, DETAILS

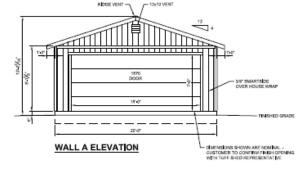

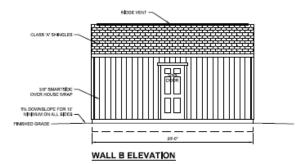

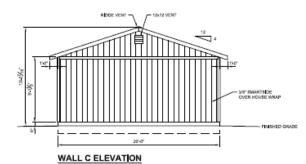

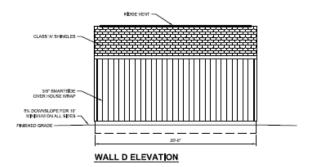

## PROJECT NOTES DESIGN REQUIREMENTS GOVERNING CODES: 2614 RC OCCUPANCY GROUP: CROUP U CONSTRUCTION TYPE; V.6 DESIGN SCHEDULE A. BUILDING SIZE WIDTH; 20'-0" LENGTH; 20'-0" ENGTH: 28'4" SIDE WALL HEIGHT: 5'4 10" TOTAL HEIGHT: 12' 2'36" B, ROOF PTCH: 412 C, BULLDHOL CAGE ROOF LIVE LOAD: 36 PSF ROOF DEAD LOAD: 16 PSF D, DESIGN WIND BASIC WIND SPEED, V: 156 MPH WIND EXPOSURE; C E. SEISMIC DESIGN CATEGORY B F, SITE CLASS; D ROOFING SCHEDULE A ROOF SHEATHING SHALL BE APAIRATED 7/19" THICK OSS WITH FOIL. BACKING, 3416 RATED MIN, UNBLOCKED DIAPHRAGM, STAGGER LAYOUT PER APA CONDITION 1. B, SHEATHING NALING SHALL BE PER NALING SCHEDULE, C. LIVETIME DIMENSIONAL ASPHALT SHINGLES (UN. O.). C. I PETITIVE CIMENTONIA, ADMINIATE PRINCIPES (U.A.D.) (I) APE FILT MADER FORCE TRANSING RECORDED ALL BIDES. E. THE D NETAL BIDES AND SERVICE AND ALL BIDES. E. THE D NETAL BIDES AND SERVICE AND ALL BIDES. IN THIS SERVICE THUS SERVED FOR THIS SERVED AND MATERIALS. H. TRUSSES MUST BE SHADED ACCORDING TO THE LATEST BOTTON FOR THE BULDING COMPORTION EASIETY PROFINATION MODER TO GOOD PRACTICE OF WITH A PLATE CONNECTED WOOD TRUSSES (SCS). THE TRUSS PLATE BOTTON FOR THE MADER MADER AND THE PROPERTION. A. THE TRUSS PLATE BOTTON FOR THE MADER AND THE PROPERTION. THE RESEARCH SERVICE AND THE PROPERTION. K, TRUSS MANUFACTURER, TUFF SHED, INC. WOOD FRAMING A. ALL MEADERS ARE SPF AZ (U.N.D.). B. ALL WALL FRAMING MEMBERS SHALL BE SPF STUD GRADE OR BETTER. B. ALL WALL FRAMING MEMBERS SHALL BE SPF STUD GRADE OR BETTER. B. ALL WELL FRAMING MEMBERS SHALL BE SPF STUD GRADE OR BETTER. B. ALL WELL FRAMING MEMBERS SHALL BE SPF STUD GRADE OR BETTER. B. ALL WELL FRAMING MEMBERS SHALL BE SPF STUD GRADE OR BETTER. B. ALL WELL FRAMING MEMBERS SHALL BE SPF STUD GRADE OR BETTER. B. ALL WELL FRAMING MEMBERS SHALL BE SPF STUD GRADE OR BETTER. B. ALL WELL FRAMING MEMBERS SHALL BE SPF STUD GRADE OR BETTER. B. ALL WELL FRAMING MEMBERS SHALL BE SPF STUD GRADE OR BETTER. B. 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A MIN, RECARRED SOLLTYPE SHALL BE CLAY, SANDY CLAY, SILTY CLAY, OR CLAYEY SLT (CL, MI, MIN & CH), PRESCRIPTIVE ALL DWARLE SOL. BEARING PRESSURE USED IN DESIGN B 1969 PSF AT 49" DEEP, VALUES ARE PER PRISSURE USED IN WESTON IS 1000 FOR AT 4F USED, VALUES AND FOR TABLE RESTAURANCE. 8. ALL FOOTHES SHALL BE FOUNDED ON UNDBITURBED NATURAL SOIL. C. IN THE EVENT OF THE DISCOVERY OF EXPANSIVE SOILS OR UNIVAVIOUSLE. CONDITIONS, THE SERVICES OF A SOILS ENGINEER MAY BE REQUIRED. A PERMIT APPLICATIONS, WHERE NO PERMIT IS ISSUED, SHALL EXPIRE PER LIMITATIONS SET BY LOCAL COORS, SECTION R195, B. JOB CARD REQUIRED TO BE AVAILABLE FOR SIZNATURE AT JOB SITE A INSTALLATION PROCEDURES SHALL CONFORM TO OSHA STANDARDS, BUILDER SHALL PROTECT ALL ADJACENT PROPERTY, STRUCTURES, TREES. UTILITIES, ETC. B. BULDER IS RESPONSIBLE FOR SAFETY OF BUILDING DURING B. SALIZIOR IS PERFONDILE FOR SAFETY OF SALIZING QUINNS CONSTRUCTIVE, PRODUCE ALL PAIDING OR BRACKING AS REQUIRED AND PER ORGANIZING SOCIALITIONS. C. ALL WOOD CONSTRUCTION CONNECTORS REFERENCED IN THIS GRAWING SHALL BE SAMPLEN STRONG-THE OR EQUIPMENT INSTALLED PER MANUFACTURES SPECIFICATION. D. ORIEDNI NÍVEL SINGER NALIS DO NOT MEET THE NALING REQUIREMENTS OF COMMONNALIS. A MATERIAL EVALUATION REPORT IDENTIFICATION A. TRUSS CONNECTION PLATES BY EAGLE METAL PLATES PER ICGES REPORT ASSERTINGS. B. SWARTSIDE SIZEND BY UP COMPORATION PER CC ES REPORT SESR (56), C. HARDIE PANEL SIDING BY JAMES HARDIE BUILDING PRODUCTS PER DOJES REPORT BESR 1894. D. HANDLE PLANK LAP SIDNG BY JAMES HANDLE BUILDING PRODUCTS PER DOJES REPORT BESR 6294. E. LAMINATED VENEER LUMBER (LVL) BY WEYERHAELISER PER ICC ES REPORT RESR 1587. F. ASPHALT SHINGLES BY GAF PER ICC ES REPORT RESR 1475. G. FELTBUSTER ROOFING UNDERLAYMENT BY GAF PER. CC-ES REPORT ASSR-2505. H, HOU PREDEFLECTED HOLD DOWNS BY SIMPSON STRONG TE PER CC-DS REPORT ASSR 2330. SSTE ANCHOR BOUTS BY SIMPSON STRONG TE PER CC-DS REPORT ASSR 2811.

Enawn By; AMX Date: 4-27-23 Checked By: Date: Revised: Revised PROJECT NOTES ELEVATIONS cale: 1/4" = 1'-0" Sheet










## ► Ward 4

▶RGD REALTY, LLC (OWN/APP) has filed an application to expand an existing car wash use, construct three additions encroaching into front and rear setbacks, and to increased signage allowance at 801 Oaklawn Avenue; A.P.18, lot 1603; area 23,652 s.f; zoned C-2. Applicant seeks relief per Section 17.92.010-Variances; Sections 17.20.120 Schedule of Intensity; 17.88.030 (A)- Extension.

► Application filed on 11/12/2024. Attorney Joseph Brennan, Esq.



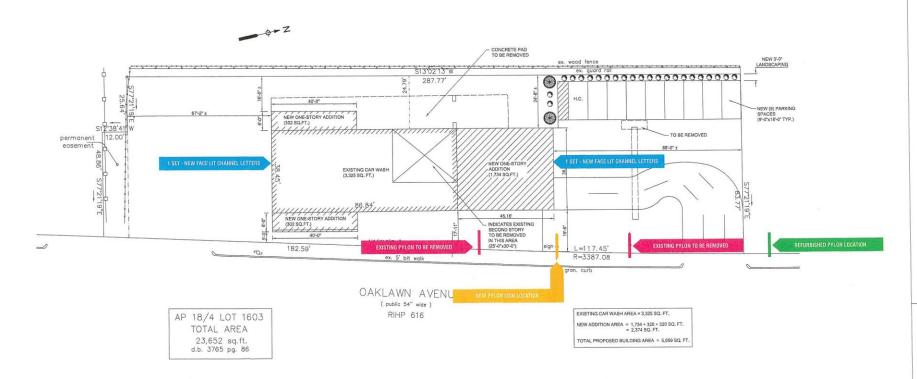

PROPOSED SITE PLAN

SCALE: 11-0\*

## 87272

Version 02 11-04-24

#### Freeway Car Wash

801 Oaklawn Ave. Cranston, RI

> Exterior Signage



1200 Fall River Ave. Seekonk, MA 508-336-5858

SALES REPRESENTATIVE
Ryan Beattie

INTERNAL PROJECT MANAGER

FIELD MANAGER


ACCOUNT COORDINATOR
Michaela Valentino

DESIGNER BM

SCALE 10%

# **05** of 05

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PROPOSED SITE PLAN

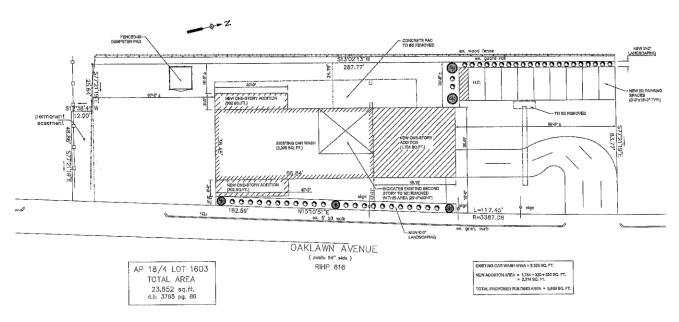PROPOSED ADDITIONS 801 OAKLAWN AVENUE CRANSTON, RHODE ISLAND

DRAWN BY: MGL

CHECKED BY: RJL

LOQA ENGINEERS, LLC CONSULTING ENGINEERS 49 BATCHELLER AVENUE PROVIDENCE, RI 02904 rjloqa@verizon.net

SCALE:

AS NOTED

SITE PLAN


DATE:

OCTOBER 2024

SHEET NO:

C100

## PROPOSED SIDE ELEVATION GCALE: 1/40"

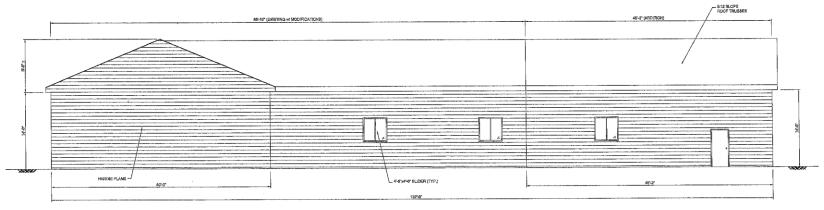

PROPOSED FRONT ELEVATION

# PROPOSED ADDITIONS 801 OAKLAWN AVENUE CRANSTON, RHODE ISLAND

DRAWN BY: MGL

CHECKED BY: RJL

LOQA ENGINEERS, LLC CONSULTING ENGINEERS 49 BATCHELLER AVENUE PROVIDENCE, RI 02904 rjloqa@verizon.net

SCALE: AS NOTED

CONTENTS:

ELEVATIONS

DATE:

OCTOBER 2024

SHEET NO:

S200

#### Sign Removal

Quantity: 2 Pylons / 1 Awning




- Sign Removal / Disposal

  "Unlimited" Pylon Sign Removal / Disposal

  Existing Awning Structure Removal / Disposal



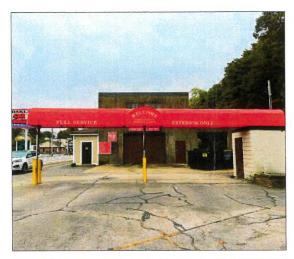





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INTERNAL PROJECT MANAGER

FIELD MANAGER

ACCOUNT COORDINATOR Michaela Valentino

DESIGNER BM


SCALE 10%

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## 

· Stud Mounted Flush to Wall



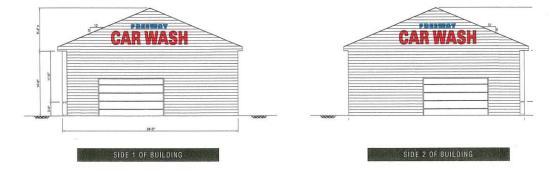

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DESIGNER BM

SCALE 10%

# **01** of 05


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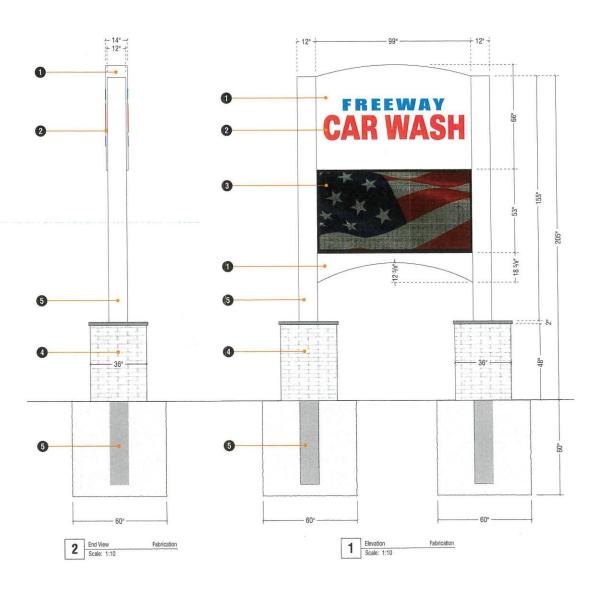
#### Pylon Sign

Quantity: 1 Double-Sided

- Sign Cabinet / Structure (LED)
  - 1" Sq. Tube Aluminum Frame
  - 1/8" Aluminum Faces (Stencil-Cut) (Painted: White)
  - . .090 Aluminum Skirting (Painted: White)
- @ Graphics (Illuminated)
  - . 1/2" White Acrylic Push-Thru Graphics
  - . Trans Vinyl Applied to Face (Red / Blue)
- Digital Displays
   \* 8mm Full Color Watchfire Electronic Message Center
- Masonry (By Others)
   White Brick with 2" Limestone Cap
- 6 Installation
  - 12" x 1/4" Steel Tube Post (Painted: White)
  - . Direct Burial into Concrete Footing

This sign is intended to be installed in accordance with the requirements of Article 600 of the National Electrical Code and/or other applicable local codes. This includes proper grounding and bonding of the sign.



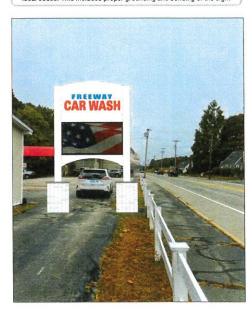

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Version 02 11-04-24

#### Freeway Car Wash

801 Oaklawn Ave. Cranston, RI

> Exterior Signage



1200 Fall River Ave. Seekonk, MA 508-336-5858

#### SALES REPRESENTATIVE Ryan Beattie

INTERNAL PROJECT MANAGER

FIELD MANAGER

ACCOUNT COORDINATOR Michaela Valentino

DESIGNER

SCALE 10%

#### SHEET **02** of 05

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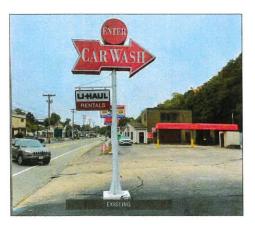
#### Repair / Refurbish Existing Pylon Sign


Quantity: 1 Double-Sided

- Sign Cabinets (Non-Illuminated)
  Reface with 1/8" Aluminum (Painted: Red TBD)

  0.63 Aluminum Skirting / Returns (Painted: Red TBD)
  - · Frisketed Graphics
- Existing Pole
  Scrape / Repaint (White)
  Remove Existing UHaul Sign and Bracket





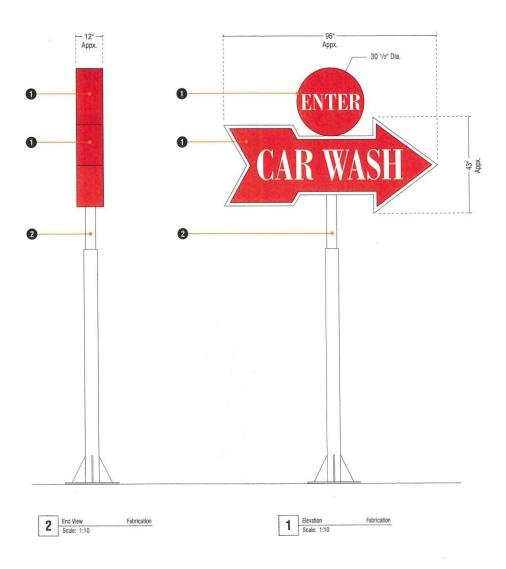

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ACCOUNT COORDINATOR
Michaela Valentino

DESIGNER BM

SCALE 10%


### SHEET **03** of 05


DOZOO This document and the designs herein sero produced crossessy for this project and remain the project of Sign Distron. Not. This year as the improvement or used the region surface. They trip set the improvement or used the region purpose without the without consent administration of Sign Distrips. At the colors printed on this page are safety representational and strained not be employed in production of any way suffer so middle and the consention with this project. Refer to calls spec, show the purpose manifer metal and systems decisions.









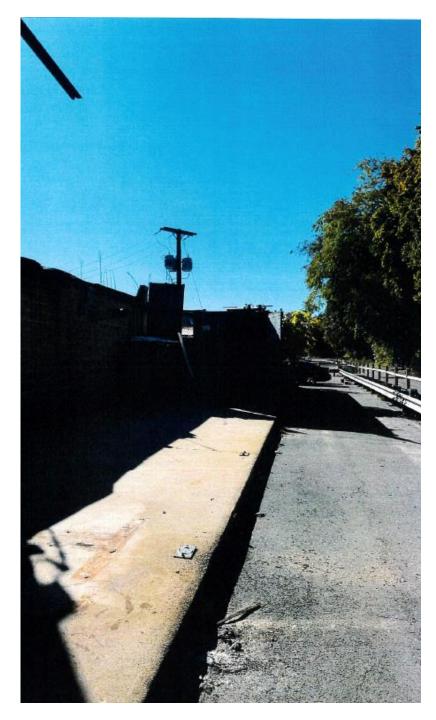

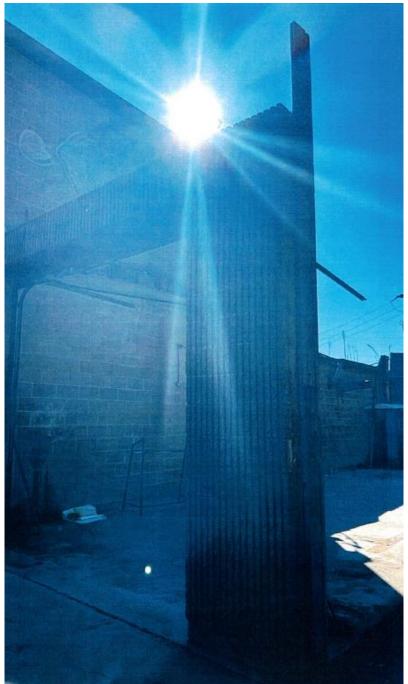

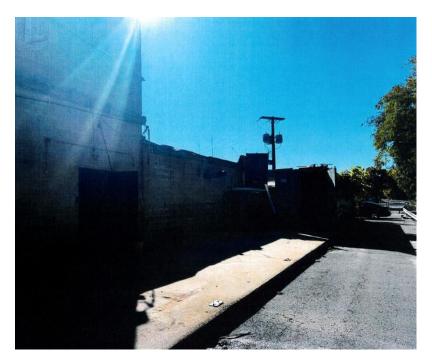



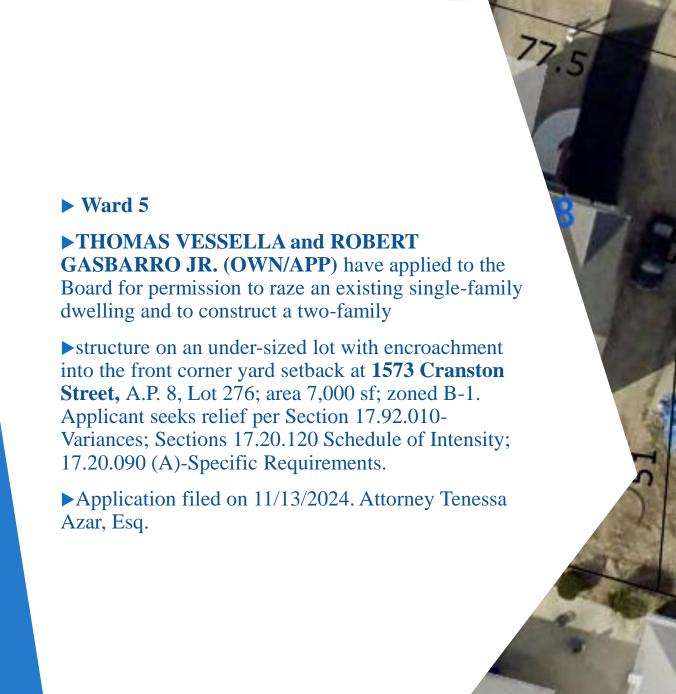


## 1573 Cranston St 400' Radius Plat 8 Lot 276





---- W- WATER LINE 123/1234 DEED BOOK/PAGE O BOLLARD AP ASSESSOR'S PLAT SOIL EVALUATION ---- SEWER LINE ---- SEWER FORCE MAIN HC HANDICAPPED CATCH BASIN --- GAS LINE N/F NOW OR FORMERLY DOUBLE CATCH BASIN ---- ELECTRIC LINE WATER VALVE I C | ANDSCAPING ---- OVERHEAD WIRES (R) RECORD GAS VALVE --- - DRAINAGE LINE (CA) CHORD ANGLE ▲8-I WETLAND FLAG MINOR CONTOUR LINE A NAIL/SPIKE O DRAINAGE MANHOLE ---5--- MAJOR CONTOUR LINE O DRILL HOLE ■ FLARED END SECTION PROPERTY LINE IRON ROD/PIPE GUY POLE ---- ASSESSORS LINE BOUND O ELECTRIC MANHOLE TREELINE 8 SIGN POST OUP UTILITY/POWER POLE GUARDRAIL SEWER MANHOLE \* LIGHTPOST SEWER CLEANOUT
 WELL FENCE RETAINING WALL X HYDRANT MONITORING WELL A IRRIGATION VALVE . BENCH MARK STONE WALL

UNKNOWN MANHOLE TREE

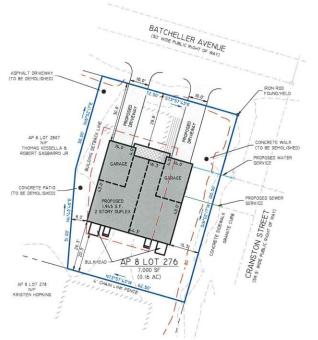

#### GENERAL NOTES

- THIS SITE IS LOCATED IN FEMA FLOOD ZONE X. REFERENCE FEMA FLOOD INSURANCE RATE MAP ALGOTCOSICH, MAP REVISED GCTOBER 2, 2015. THIS DESIGNATION MAY CHANGE BASED UPON REVIEW BY A FLOOD ZONE SPECIALIST OR BY THE RESULTS OF A COMPREHENSIVE FLOOD STUDY.
- THIS SURVEY WAS PREPARED WITHOUT THE BENEFIT OF A TITLE REPORT. DIPRETE ENGINEERING IS NOT RESPONSIBLE FOR ANY UNKNOWN OR UNRECORDED EASEMENTS, DEEDS OR CLAIMS THAT A TITLE REPORT WOULD DISCLOSE.
- 3. HOUSE LAYOUT BASED ON "40 X 44 DUPLEX" PREPARED BY DLR DIMENSIONS.
- 4. EXISTING DWELLING TO BE RAZED.
- THE PARCEL IS FOUND ON ASSESSOR'S PLAT 8 LOT 276 IN THE CITY OF CRANSTON, PROVIDENCE COUNTY, RHODE ISLAND.
- 6. THE OWNER PER DEED BOOK 6589, PAGE 203 IS THOMAS VESSELLA & ROBERT GASBARRO JR.
- FIELD SURVEY PERFORMED BY DIPRETE ENGINEERING ON DECEMBER 7, 2021. THIS PLAN REFLECTS ON THE GROUND CONDITIONS AS OF THAT DATE.

#### PLAN REFERENCES

- "PLAT OF LAND IN CRANSTON, R.I., BELONGING TO STEPHEN MATHEWSON', SURVEYED & PLATTED DEC. 1874, DRAWN BY J.A. LATHAM., SCALE 80 FT TO AN INCH.
- MINOR SUBDIVISION RECORD PLAN, 1573 CRANSTON STREET SUBDIVISION' PREPARED FOR THOMAS
  WEBILLA & ROBERT GASBARRO, JR. PREPARED BY DIPRETE ENGINEERING, DATED SEPTEMBER 9, 2022
  SCALE "F20" PLAN BOOK 38, PAGE 72.

#### ZONING NOTES

I. THE PARCEL AND ALL ABUTTING PARCELS ARE ZONED B-I PER THE ASSESSOR'S ONLINE DATABASE.

DIMENSIONAL REQUIREMENTS BASED ON EXISTING CRANSTON ZONING ORDINANCE SECTION 17.20.120 AND RIGL 45-24-38

MINIMUM LOT AREA
MINIMUM FRONTAGE AND LOT WIDTH
MINIMUM FRONT YARD (BATCHELLER AVE) 25 FEET
MINIMUM FRONT YARD (FARSHON ST) 25 FEET PROVIDED 7,000 SQUARE FEET\* 72.50 FEET 28.8 FEET 15.3 FEET\* 8 FEET 20.3 FEET 25 FEET 8 FEET 20 FEET MINIMUM SIDE YARD MINIMUM REAR YARD

\*RELIEF REQUESTED
TABLE 17. 20.120 - MINIMUM LOT AREA
TABLE 17. 20.090(A) - SPECIFIC REQUIREMENTS
TABLE 17. 20.120 - MINIMUM FRONT YARD

DiPrete

Engineering

SUBDIVIS

TREE.

S

GASBARRO ROBERT ď

PLAN CRANSTON S PLAT 8 APO LOT 276 RHODE ISLAND VESSELLA HOMAS 2

## SURVEYOR'S CERTIFICATE


THIS SURVEY HAS BEEN CONDUCTED AND THE PLAN HAS BEEN PREPARED PURSUANT TO 435-RICK-00-00-1-9 OF THE RULES AND REGULATIONS ADOPTED BY THE RHODE IS,AND STATE BOARD OF REGISTRATION FOR PROFESSIONAL LAND SURVEYORS ON NOVEMBER 25, 2015, 45 FOLLOWS:


 LIMITED CONTENT BOUNDARY SURVEY (BUILDING LOCATION SURVEY) TOPOGRAPHIC SURVEY


CLASS I CLASS T-2


THE PURPOSE FOR THE CONDUCT OF THE SURVEY AND FOR THE PREPARATION OF THE PLAN IS AS FOLLOWS: DEPICT THE RELATIONSHIP BETWEEN THE LOT LINES AND PROPOSED BUILDING FOR THE PURPOSE OF OBTAINING A BUILDING PERMIT.



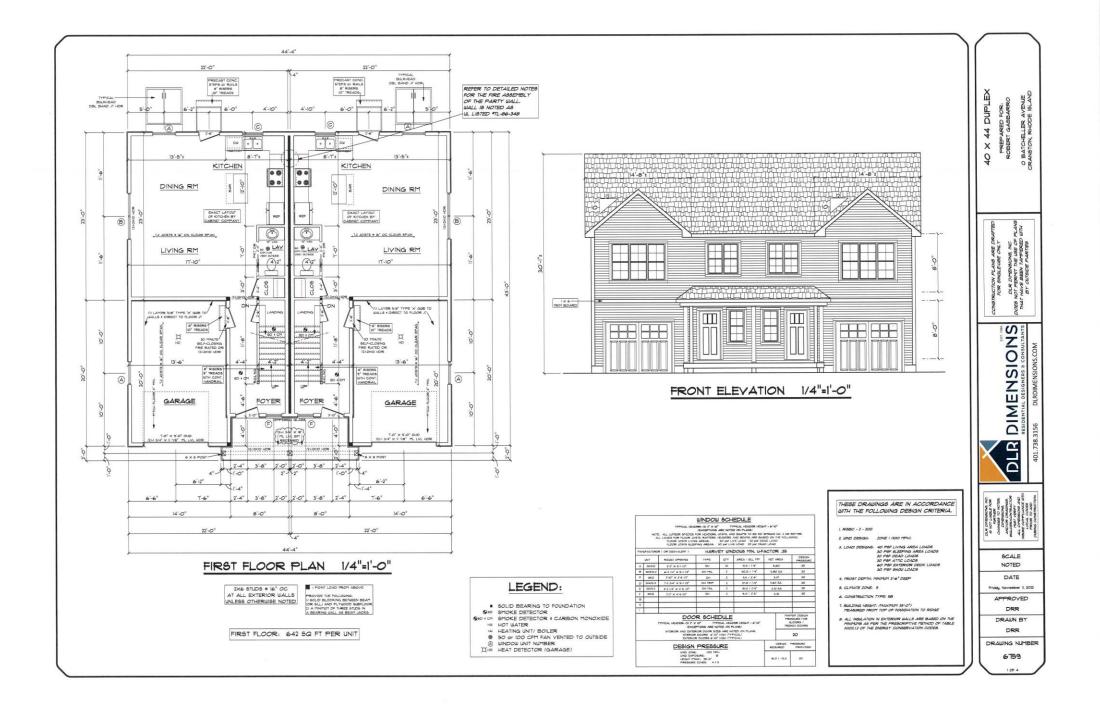

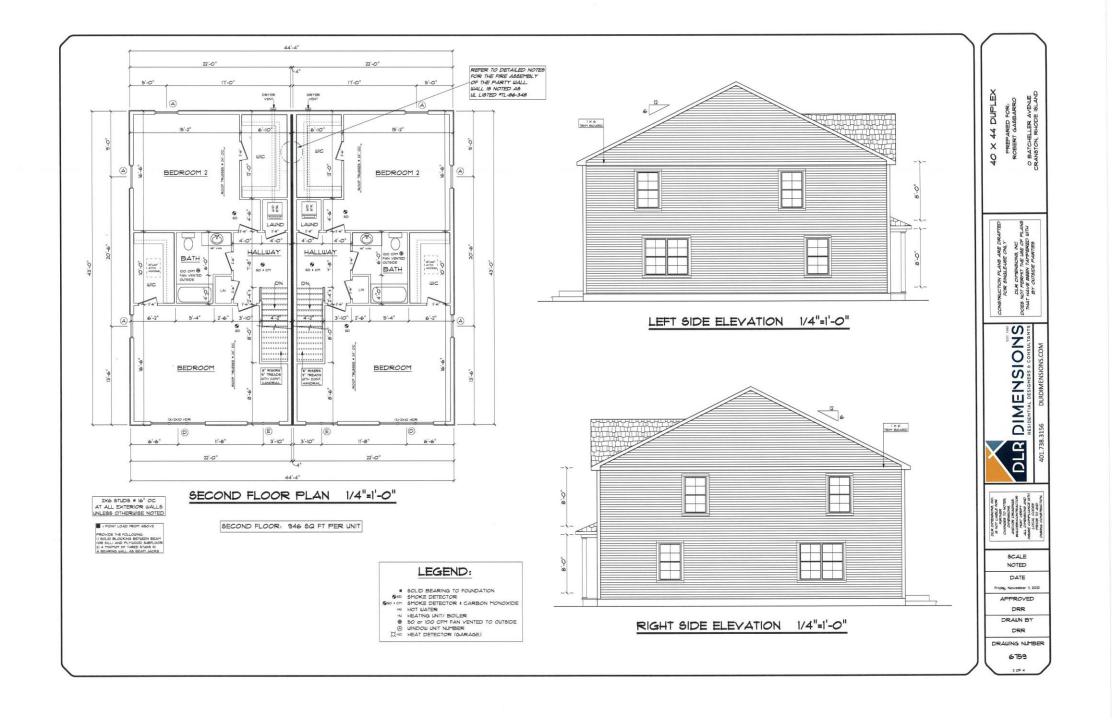

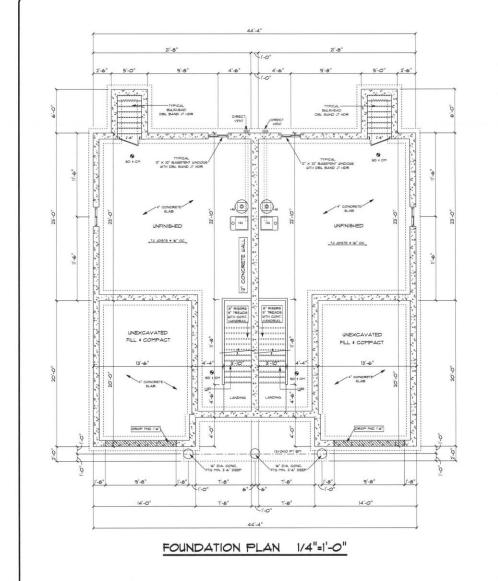

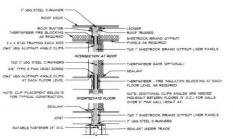

#### SECTION VIEW



SOLD AREA SEPARATION WALL - V2" SHETTROCK BRAND GYPRUP PANELS - TWO 7" SHETROCK BRAND GYPRUP LIKER PANELS SET SETLETEN BROOK BRAND GYPRUP LIKER PANELS SET SETLETEN BROOK BROOK LIKER PANELS SET SETLETEN LIKE PANELS SETLETEN LIKER PANELS SETLET

#### PLAN VIEW

## PARTY WALL DETAIL ~ 1/2"=1'-0"

TYPICAL NAUNG SCHIDLE
TYPICAL FLOORS
JUST TO BLOK SINDER, TOE NAL (3) 80
RHI JUST TO JUST (3) 800
RAL SHI STARLE OR IUT RING OR SCRIED BLANK
NALS \* © FRON EDGE ST (3).

TYPICAL BULT-UP GIRDERS AND BEAMS NAIL EACH LATER WITH IOD NAILS \* 32° C.C. AT TOP AND BOTTOM STAGGERED. TWO NAILS AT ENDS AND AT EACH SPLICE.

TYPICAL BALLS
BOTTOM PLATE (0) JOHN BD + B<sup>1</sup> D.C.
SHID TO BOTTOM PLATE (0) JOHN BD ON 30 BD
SHID TO BOTTOM PLATE (0) JOHN BD
SHID TO BOTTOM PLATE (0) JOHN BD
DOUBLES SHID TO BOT AND BD
DOUBLES SHID (0) JOHN BD
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GENERAL NOTES EGRESS UNDOUS IN ALL BEDROOMS AS PER CODE

SMOKE DETECTORS I CARBON MONOXIDE AS PER FIRE PROTECTION CODE.

PROVIDE A 2" × 30" ATTIC ACCESS OPENING

ALL DIMENSIONS, NOTES, AND OTHER NICORPATION CONVITTED IN THESE NEARLY SOR CONSTRUCTION PURPOSES ARE SUBJECT TO CHANGE AND SHOULD BE VIRENED IN HILLD BY MALDEN / OR THE AND SHOULD BY SOME AND SHOULD BY SHOULD BY SOME AND SHOULD BY SHOULD BY SOME SHOULD BY SHOULD BY SOME SHOUL

THIS DRAFTSPERSON SHALL NOT BE RESPONSIBLE FOR ANY GHANGES THAT BOULD MAKE THE STRUCTURE PHYSICALLY UNSAFE.

UNFOREMEN SITE CONDITIONS MAY CAUSE A DEVIATION FROM THE CONSTRUCTION DOCUMENTS AND IS THE RESPONSIBILITY OF THE BULDER / CONTRACTOR TO NOWNESTRUCTURE. STABLITY AND CONFORMANCE TO APPLICABLE CODES.

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AND BRACED IN ACCORDANCE WITH ITTPI)
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START OF CONSTRUCTION.



BACK ELEVATION 1/4"=1'-0"

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BATCHELLER AVENUE ANSTON, RHODE ISLAN

CONSTRUCTION PLANS ARE DRA FOR SNALELUSE CNLT DLR DIMENSIONS, INC DOES NOT PERSON THE USE OF P THAT HAVE BEEN THATERED

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> SCALE NOTED

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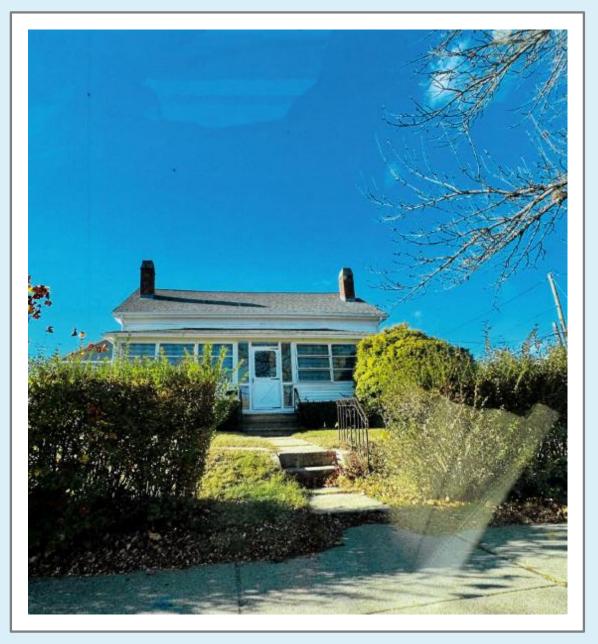
Friday, November II, 2022 APPROVED

> DRR DRAWN BY DRR

DRAWING NUMBER

6759






## ►Ward 5

▶ALEXANDRIA REALTY, LLC (OWN) and BENJAMIN VITI (APP) has filed an application to divide an existing commercial space to create an additional residential unit at 1728 Cranston Street, A.P. 11, lot 3364; area 3,528 sf; zoned C5. Applicant seeks relief per Section 17.92.010-Variances; sections 17.20.030- Schedule of Uses; 17.88.030-Extension; 17.20.090 (B)- Specific Requirements; 17.64.010- Off-Street Parking. Application filed on 11/15/2024.


► Attorney Marc B. Gertsacov, Esq.



## 1728 Cranston St 400' Radius Plat 11 Lot 3364

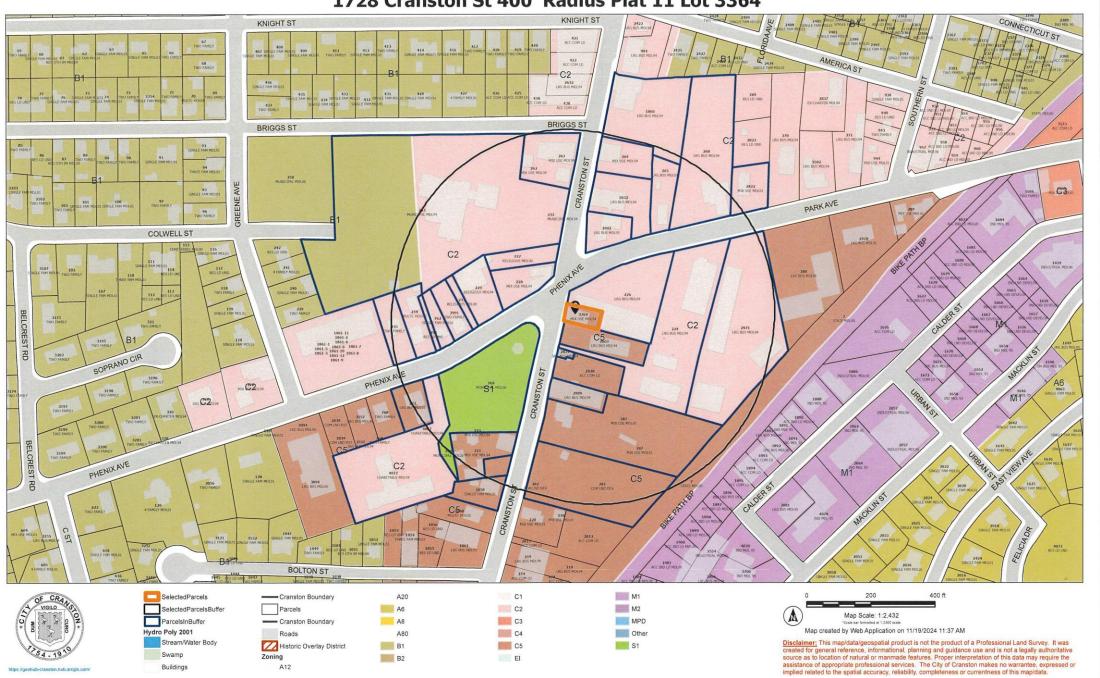

1728 Cranston St Existing Floor plan

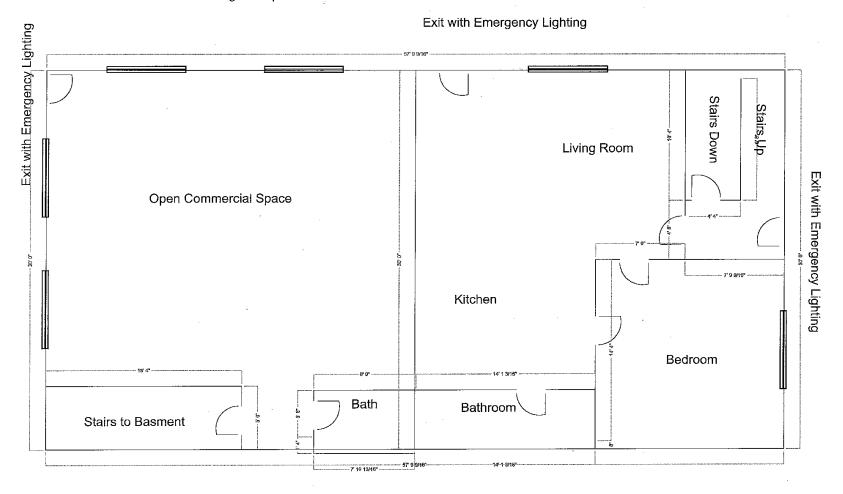

## 1728 Cranston St Existing Site Plan and Parking

